

DEPARTMENT OF REGULATORY AND ECONOMIC RESOURCES (RER) **BOARD AND CODE ADMINISTRATION DIVISION** 

NOTICE OF ACCEPTANCE (NOA)

PRODUCT CONTROL SECTION 11805 SW 26 Street, Room 208 T (786) 315-2590 F (786) 315-2599

www.miamidade.gov/economy

MIAMI-DADE COUNTY

Weather Shield Manufacturing, Inc. One Weather Shield Plaza, P. O. Box 309 Medford, WI 54451-0309

#### SCOPE:

This NOA is being issued under the applicable rules and regulations governing the use of construction materials. The documentation submitted has been reviewed and accepted by Miami-Dade County RER -Product Control Section to be used in Miami Dade County and other areas where allowed by the Authority Having Jurisdiction (AHJ).

This NOA shall not be valid after the expiration date stated below. The Miami-Dade County Product Control Section (In Miami Dade County) and/or the AHJ (in areas other than Miami Dade County) reserve the right to have this product or material tested for quality assurance purposes. If this product or material fails to perform in the accepted manner, the manufacturer will incur the expense of such testing and the AHJ may immediately revoke, modify, or suspend the use of such product or material within their jurisdiction. RER reserves the right to revoke this acceptance, if it is determined by Miami-Dade County Product Control Section that this product or material fails to meet the requirements of the applicable building code.

This product is approved as described herein, and has been designed to comply with the Florida Building Code, including the High Velocity Hurricane Zone.

**DESCRIPTION:** Series "Legacy" Outswing Aluminum Clad Wood Casement Window – L.M.I.

APPROVAL DOCUMENT: Drawing No. 1070, titled "Legacy Aluminum Clad Wood Impact Outswing Casement Window", sheets 1 through 5 of 5, dated 04/04/02, prepared by W.W. Schaefer Engineering & Consulting, P.A., with revision "C1" dated 09/17/12, signed and sealed by Warren W. Schaefer, P.E., bearing the Miami-Dade County Product Control Revision stamp with the Notice of Acceptance number and expiration date by the Miami-Dade County Product Control Section.

# MISSILE IMPACT RATING: Large and Small Missile Impact Resistant.

**LABELING:** Each unit shall bear a permanent label with the manufacturer's name or logo, city, state, model/series, and following statement: "Miami-Dade County Product Control Approved", unless otherwise noted herein.

**RENEWAL** of this NOA shall be considered after a renewal application has been filed and there has been no change in the applicable building code negatively affecting the performance of this product.

**TERMINATION** of this NOA will occur after the expiration date or if there has been a revision or change in the materials, use, and/or manufacture of the product or process. Misuse of this NOA as an endorsement of any product, for sales, advertising or any other purposes shall automatically terminate this NOA. Failure to comply with any section of this NOA shall be cause for termination and removal of NOA.

ADVERTISEMENT: The NOA number preceded by the words Miami-Dade County, Florida, and followed by the expiration date may be displayed in advertising literature. If any portion of the NOA is displayed, then it shall be done in its entirety.

**INSPECTION:** A copy of this entire NOA shall be provided to the user by the manufacturer or its distributors and shall be available for inspection at the job site at the request of the Building Official.

This NOA revises and renews NOA# 11-1108.05 and consists of this page 1 and evidence pages E-1 and E-2, as well as approval document mentioned above.

The submitted documentation was reviewed by Manuel Perez, P.E.

MIAMI-DADE COUNTY

112/14/12

NOA No. 12-0919.04 **Expiration Date: February 13, 2018** Approval Date: December 27, 2012 Page 1

# Weather Shield Manufacturing, Inc.

# NOTICE OF ACCEPTANCE: EVIDENCE SUBMITTED

## A. DRAWINGS

- 1. Manufacturer's die drawings and sections.
- 2. Drawing No. 1070, titled "Legacy Aluminum Clad Wood Impact Outswing Casement Window", sheets 1 through 5 of 5, dated 04/04/02, with revision "C1" dated 09/17/12, prepared by W.W. Schaefer Engineering & Consulting, P.A., signed and sealed by Warren W. Schaefer, P.E.

## B. TESTS

- 1. Test reports on: 1) Air Infiltration Test, per FBC, TAS 202–94
  - 2) Uniform Static Air Pressure Test, Loading per FBC TAS 202-94
  - 3) Water Resistance Test, per FBC, TAS 202-94
  - 4) Large Missile Impact Test per FBC, TAS 201-94
  - 5) Cyclic Wind Pressure Loading per FBC, TAS 203-94

along with marked-up drawings and installation diagram of an aluminum clad wood fixed casement window, prepared by Hurricane Test Laboratory, LLC, Test Reports No.: HTL 0037-0201-01, HTL 0037-0410-01, HTL 0037-1204-01,

HTL 0037-0412-01, HTL 0037-0418-01, HTL 0037-0205-01 and

HTL 0037–0106–02, dated 04/16, 04/20 and 11/21//01, 01/08, 02/07 and 07/05/02, all signed and sealed by Vinu J. Abraham, P.E.

(Submitted under previous NOA No. 07-1203.10)

## C. CALCULATIONS

- 1. Anchor verification calculations and structural analysis, dated 03/13/02, 04/14/08 and revised on 09/17/12, complying with FBC-2010, prepared by W. W. Schaefer Engineering & Consulting, P.A., signed and sealed by Warren W. Schaefer, P.E. (Partly submitted under previous NOA No. 07-1203.10)
- 2. Glazing complies with ASTM E1300-04

# D. QUALITY ASSURANCE

1. Miami-Dade Department of Regulatory and Economic Resources (RER)

# E. MATERIAL CERTIFICATIONS

- 1. Notice of Acceptance No. 11–1102.11 issued to Solutia, Inc. for their "Saflex Clear and Color Glass Interlayers" dated 06/14/12, expiring on 05/21/16
- 2. Notice of Acceptance No. 07–0831.06 issued to Cardinal LG for their "Laminated Glass Cardinal Sea-Storm Type B", dated 10/11/07, expiring on 12/30/12.

Manuel Perez, P.E. Product Control Examiner NOA No. 12-0919.04

Expiration Date: February 13, 2018 Approval Date: December 27, 2012

# Weather Shield Manufacturing, Inc.

# NOTICE OF ACCEPTANCE: EVIDENCE SUBMITTED

# F. STATEMENTS

- 1. Statement letter of conformance, complying with FBC-2010, dated 09/17/12, signed and sealed by Warren W. Schaefer, P. E.
- 2. Statement letter of no financial interest and independence, dated 09/17/12, signed and sealed by Warren W. Schaefer, P. E.
- 3. Laboratory compliance letters for Test Reports No.'s HTL 0037–0201–01, HTL 0037–0410–01, HTL 0037–1204–01, HTL 0037–0412–01, HTL 0037–0418–01, HTL 0037–0205–01 and HTL 0037–0106–02, issued by Hurricane Test Laboratory, LLC, dated 04/16, 04/20 and 11/21//01, 01/08, 02/07 and 07/05/02, signed and sealed by Vinu J. Abraham, P.E.


(Submitted under previous NOA No. 07-1203.10)

## G. OTHERS

1. Notice of Acceptance No. 11–1108.05, issued to Weather Shield Manufacturing, Inc. for their Series "Legacy Aluminum Clad Outswing Wood Casement Window – L.M.I." approved on 01/26/12 and expiring on 02/13/13.

Manuel Perez, P.E.
Product Control Examiner
NOA No. 12-0919.04

Expiration Date: February 13, 2018 Approval Date: December 27, 2012

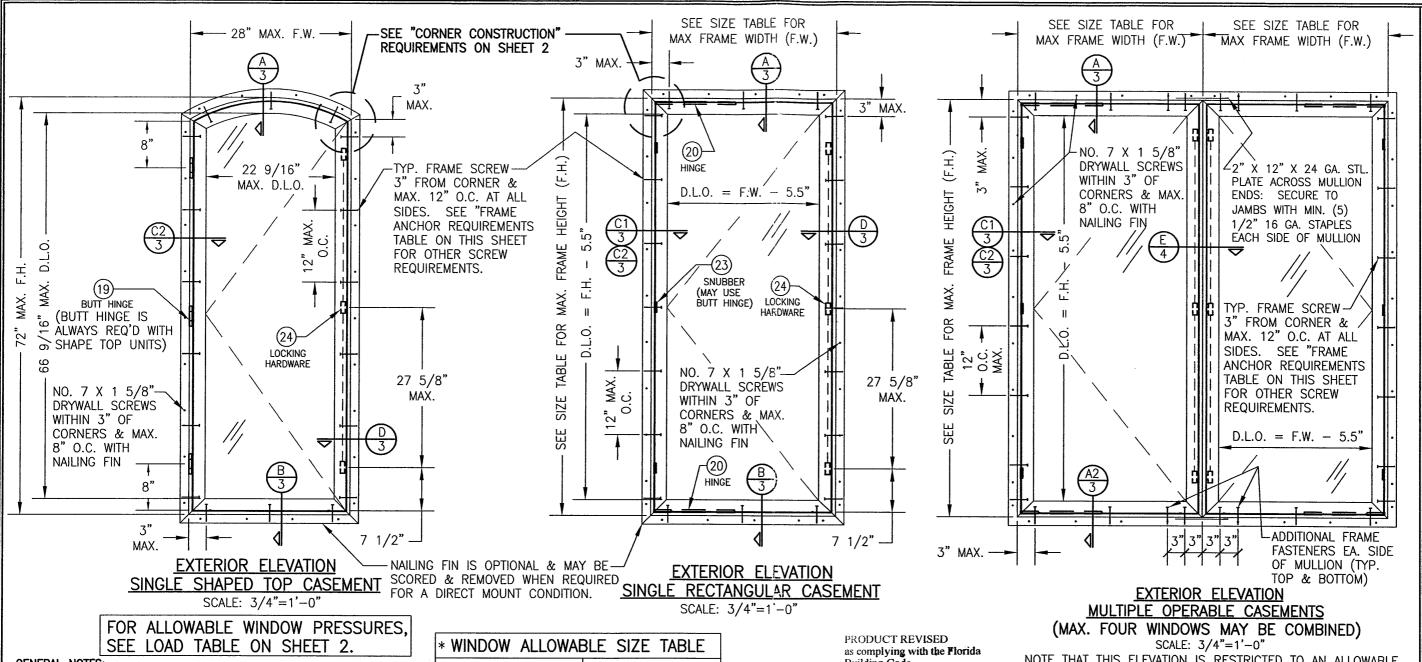

#### **GENERAL NOTES:**

1. THESE WINDOW SYSTEMS HAVE BEEN TESTED, ANALYZED & APPROVED FOR DESIGN PRESSURES NOT TO EXCEED THOSE SHOWN IN THE "ALLOWABLE DESIGN PRESSURE TABLE(S).

2. OPENINGS, BUCKING & BUCKING FASTENERS MUST BE PROPERLY DESIGNED & INSTALLED TO

TRANSFER WIND LOADS TO THE STRUCTURE.

3. ALL HARDWARE & FASTENERS SHALL BE IN ACCORDANCE WITH THESE DRAWINGS & SHALL NOT VARY UNLESS SPECIFICALLY MENTIONED ON THE DRAWINGS. SPECIFIED ANCHOR EMBED TO BASE MATERIAL SHALL BE BEYOND WALL FINISH OR STUCCO.

4. THE DETAILS & SPECIFICATIONS SHOWN HEREIN REPRESENT THE PRODUCTS TESTED & PROPOSED FOR WATER, AIR, IMPACT, CYCLIC & UNIFORM STATIC AIR PRESSURE TESTING IN CONFORMANCE WITH THE FLORIDA BUILDING CODE PROTOCALS TAS-201, 202 & 203 FOR LARGE MISSILE IMPACT

5. THESE WINDOW SYSTEMS HAVE BEEN DESIGNED IN ACCORDANCE WITH AND MEET THE REQUIREMENTS OF THE FLORIDA BUILDING CODE (FBC) INCLUDING HIGH VELOCITY HURRICANE ZONES

6. IMPACT SHUTTERS ARE NOT REQUIRED WITH THESE WINDOWS.
7. ALL ANCHORS SECURING WINDOW FRAME TO PRESSURE TREATED BUCKS OR WOOD FRAMING SHALL BE CAPABLE OF RESISTING CORROSION CAUSED BY THE PRESSURE TREATING CHEMICALS IN

8. DETERMINE THE POSITIVE & NEGATIVE DESIGN LOADS TO USE WHEN REFERENCING THESE DOCUMENTS IN ACCORDANCE WITH THE GOVERNING CODE AND GOVERNING WIND VELOCITY. FOR WIND LOAD CALCULATIONS IN ACCORDANCE WITH THE FLORIDA BUILDING CODE, A DIRECTIONALITY FACTOR OF Kd = 0.85 MAY BE APPLIED PER THE ASCE-7 STANDARD.

9. NO INCREASE IN ALLOWABLE STRESS HAS BEEN USED IN THE CERTIFICATION OF THIS PRODUCT. WIND LOAD DURATION FACTOR Cd=1.6 Was used for wood screw analysis only.

10. Materials, including but not limited to steel screws, that come into contact with other dissimilar materials shall meet the requirements of florida building code chapter

11. ALL WOOD MEMBERS OF WINDOWS THAT MAY POSSIBLY COME INTO CONTACT WITH MASONRY OR CONCRETE SUBSTRATES, ARE SUBJECT TO MOISTURE &/OR ARE SUBJECT TO THE OUTSIDE ENVIRONMENT SHALL BE OF AN APPROVED DURABLE SPECIES OR BE TREATED IN AN APPROVED METHOD WITH AN APPROVED PRESERVATIVE PER FBC SECTION 2326.

FRAME HEIGHT (F.H.)	FRAME WIDTH (F.W.)
58" & LESS	36" MAX.
59" TO 72"	32" MAX.

APPLICABLE TO RECTANGULAR WINDOWS ONLY. SHAPE TOP WINDOWS ARE LIMITED TO THOSE DIMENSIONS SHOWN IN ELEVATION

# LOCK/SNUBBER/HINGE REQUIREMENTS

	WINDOW FRAME WIDTH OF 32" & LESS			
	FRAME HEIGHT	# OF LOCKS/SNUBBERS/HINGES		
)	ABOVE 48"	3		
	48" & LESS	2		
	WINDOW FRAME WIDTH GREATER THAN 32"			
	FRAME HEIGHT	# OF LOCKS/SNUBBERS/HINGES		
	ABOVE 42"	3		
	42" & LESS	2		


Building Code Acceptance No 12-0919.04

Expiration Date Feb. 13,2018

THESE DRAWINGS ARE APPLICABLE ONLY TO THE PRODUC SPECIFIED. THEY MAY NOT BE USED FOR THE ASSEMBLY AND/OR INSTALLATION OF ANY OTHER PRODUCT NOR MAY THEY BE USED FOR RATIONAL AND/OR LOCAL APPROVAL OF ANY PRODUCT NOT PRODUCED BY THE MANUFACTURE NOTE THAT THIS ELEVATION IS RESTRICTED TO AN ALLOWABLE PRESSURE OF +60/-75 PSF. ALSO, THIS ELEVATION IS APPLICABLE TO AN OPERABLE CASEMENT MULLED TO A FIXED CASEMENT AT AN ALLOWABLE PRESSURE OF +60/-75 PSF. SEE ELEVATIONS ON SHEET 2 FOR OTHER MULLED CONDITIONS OF OPERABLE TO FIXED

FRAME ANCHOR REQUIREMENTS TABLE					
OPENING TYPE (SUBSTRATE)	JAMB TO OPENING FASTENER TYPE	MINIMUM EMBEDMENT	MINIMUM EDGE DIST.		
MIN. 2X4 WOOD FRAME OR BUCK (MIN. GR. 3 & G=0.55)	NO. 10 SMS SCREW	1 3/8"	1"		
MIN. C-90 CMU OR 2500 PSI CONCRETE	3/16" CONCR. SCREW	1 1/4"	2"		
CONCRETE SCREWS SHALL	BE ELCO ULTRACONS	, ITW RAMS	ET/RED		

HEAD TAPCONS, HILTI KWIK-CON II OR POWERS RAWL TAPPER (HARDENED STEEL OR S.S.)

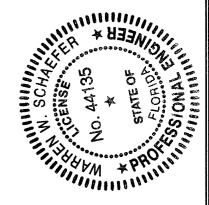

DRAWING TIT LEGAC	CONSULTANT W. W. S(	7480 PALM BI	
CERTIFICATION	SEP 17 2012	WAKREN W. SCHAEFER, P.E.	
1	wing no. 070	REV.	
SI 1	HEET NO. OF	5	

CHECKED BY

04/04/02

E WEATHER SHIELD PLAZA
MEDFORD, WI 54451
715-748-6555

WINDOW

CASEMENT

OUTSWING

**IMPACT** 

WOOD

CLAD


ALUMINUM

WEATHER

ONE

P.A. (CA 6809)
NURT NORTH
ENS. FL 33418

HAEFER JLTING, F

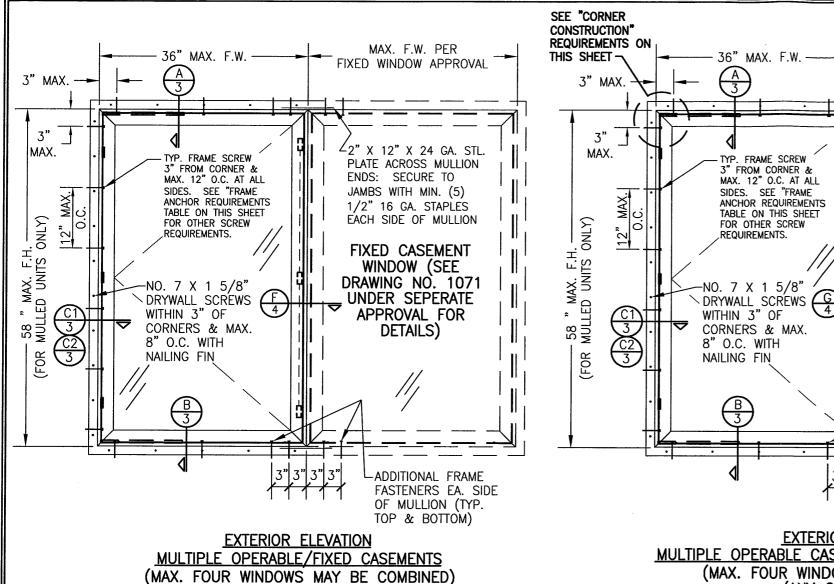

MAX. F.W. PER DIRECT SET APPROVAL ∠2"X 12"X 24 GA. STL. PLATE ACROSS MULLION ENDS: SECURE TO JAMBS WITH MIN. (5) 1/2" 16 GA. STAPLES EACH SIDE OF MULLION DIRECT SET WINDOW (SEE DRAWING NO. 1072 G 4 UNDER SEPERATE APPROVAL FOR DETAILS) ADDITIONAL FRAME FASTENERS EA. SIDE OF MULLION (TYP.

> EXTERIOR ELEVATION MULTIPLE OPERABLE CASEMENTS/DIRECT SET WINDOWS (MAX. FOUR WINDOWS MAY BE COMBINED) (ANY COMBINATION) SCALE: 3/4"=1'-0"

TOP & BOTTOM)

(FOR DETAIL NOT SHOWN SEE ELEVATIONS ON SHEET 1) ALLOWABLE PRESSURE

= MAX.  $\pm$  60 PSF AT OPERABLE TO DIRECT SET UNITS SHOWN.

#### (SINGLE WINDOWS) HEIGHT ALLOWABLE PRESSURE (PSF) WIDTH (IN.) (IN.) GLASS OPTION GLASS OPTION 2, 3 & 4 P<sub>0</sub>S NEG NEG POS 28 OR LESS 60.0 60.0 85.0 85.0 60.0 75.0 32 75.0 60.0 OR LESS 36 60.0 75.0 60.0 75.0 28 OR LESS 60.0 75.0 60.0 75.0 75.0 32 60.0 75.0 60.0 52 36 60.0 75.0 60.0 75.0 75.0 28 OR LESS 60.0 60.0 75.0 32 60.0 75.0 60.0 75.0 56 36 60.0 75.0 60.0 75.0 WINDOW 28 OR LESS 75.0 60.0 75.0 60.0 60.0 75.0 32 60.0 75.0 36 75.0 60.0 70.2 60.0 28 OR LESS 60.0 75.0 60.0 75.0 32 60.0 75.0 60.0 75.0 75.0 28 OR LESS 60.0 75.0 60.0 64 32 60.0 75.0 60.0 75.0 OUTSWING 28 OR LESS 60.0 75.0 60.0 75.0 68 32 75.0 60.0 60.0 75.0 75.0 60.0 75.0 28 OR LESS 60.0 72 60.0 75.0 60.0 75.0 GLASS OPTION 1 = 3/8" CARDINAL SEASTORM LAMINATED ANNEALED GLASS (5/32" PANES) GLASS OPTION 2 = 7/16" SOLUTIA SAFLEX WOOD

ALLOWABLE WINDOW PRESSURE

LAMINATED HEAT STRENGTHENED (3/16" PANES)
GLASS OPTION 3 = 7/16" SOLUTIA SAFLEX
LAMINATED ANNEALED (3/16" PANES)

# FRAME CORNER CONTRUCTION

AT EACH CORNER THE WOOD FRAME MEMBERS ARE COPED, SEALED WITH GE 2801 SILGLAZE THEN BUTTED TOGETHER AND MECHANICALLY FASTENED USING THREE (3) 1/2" X 1 1/2" LONG 16 GA. GALVANIZED STEEL STAPLES.

(ANY COMBINATION)

SCALE: 3/4"=1'-0"

(FOR DETAIL NOT SHOWN SEE ELEVATIONS ON SHEET 1)

ALLOWABLE PRESSURE

AT OPERABLE TO FIXED

UNITS SHOWN ABOVE.

= MAX,  $\pm$  60 PSF

AT EACH CORNER THE ALUMINUM FRAME CLADDING MEMBERS ARE MITER CUT, SEALED, BUTTED TOGETHER AND MECHANICALLY FASTENED USING ONE (1) NO. 7 X 3/8" FH UNDERCUT FASTENER. THE FRAME CLAD CORNERS ARE REINFORCED WITH AN INSERTED GLASS FILLED CORNER KEY. A PSA1 CLOSED CELL FOAM CORNER GASKET IS APPLIED AT EACH FRAME CORNER SEALING THE JOINT BETWEEN ADJOINING MEMBERS.

# SASH CORNER CONSTRUCTION

WHEN WINDOW WIDTHS ARE 32" OR LESS, THE MULLION SPAN (WINDOW HEIGHT) MAY

BE INCREASED TO 72" AND THE ALLOWABLE

PRESSURE MAY BE INCREASED TO +60/-75

PSF. (OPERABLE TO FIXED CASEMENT ONLY)

AT EACH CORNER THE WOOD SASH MEMBERS ARE COPED, SEALED WITH GE 2801 SILGLAZE THEN BUTTED TOGETHER AND MECHANICALLY FASTENED USING ONE (1) F16 X 1 3/4" FINISH NAIL

AT EACH CORNER THE ALUMINUM SASH CLADDING MEMBERS ARE MITER CUT, SEALED, BUTTED TOGETHER AND MECHANICALLY FASTENED USING TWO (2) NO. 6 X 1 1/4" PILOT POINT SCREWS. THE SASH CLAD CORNERS ARE REINFORCED WITH AN INSERTED ZINC DIE CAST CORNER KEY.

PRODUCT REVISED as complying with the Florida Building Code Acceptance No 12-0919. Building Code Expiration Date Feb. 13, 2018

THE A HEAVEN NO. 4413F

કં∗્ર SCHAEFER, NO. 44135 2012 SEP

W.W.S.

E WEATHER SHIELD PLAZA MEDFORD, WI 54451 715-748-6555

SHIELD

WEATHER ONE

ENGINEERING P.A. (CA 6809)

CLAD

**ALUMINUM** 


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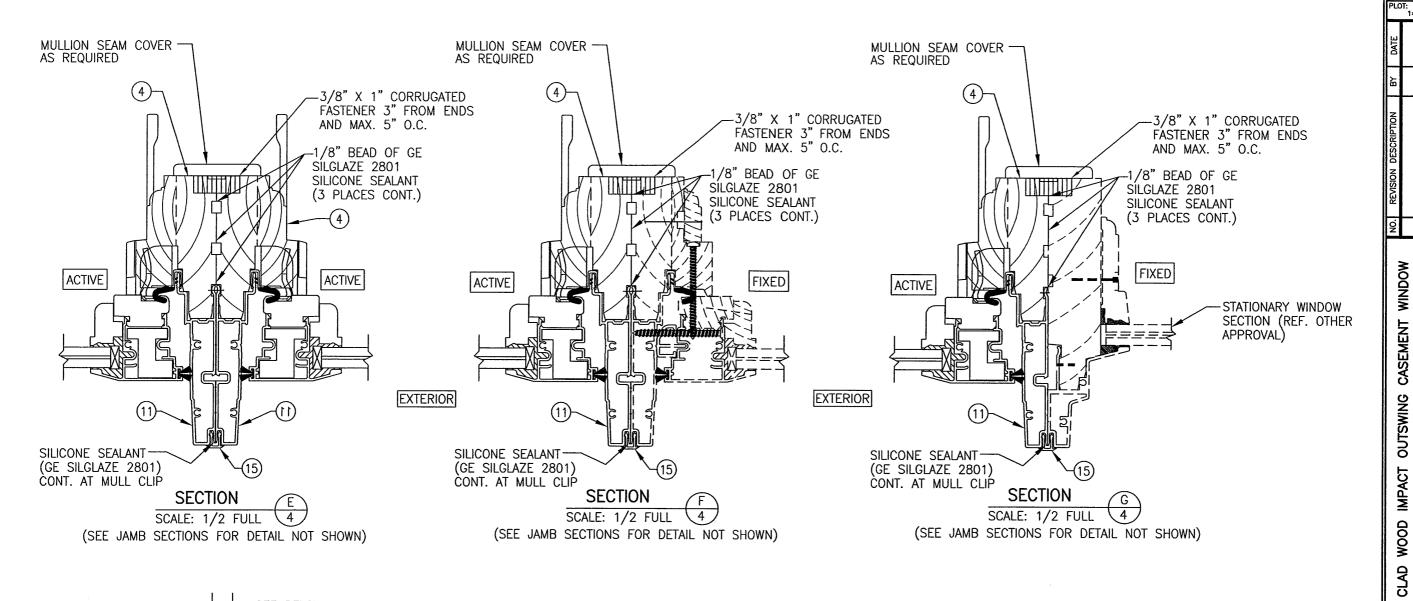
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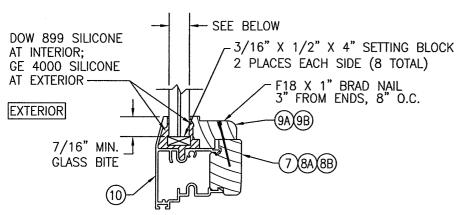
1070

SHEET NO OF

Miami Dade Product Control






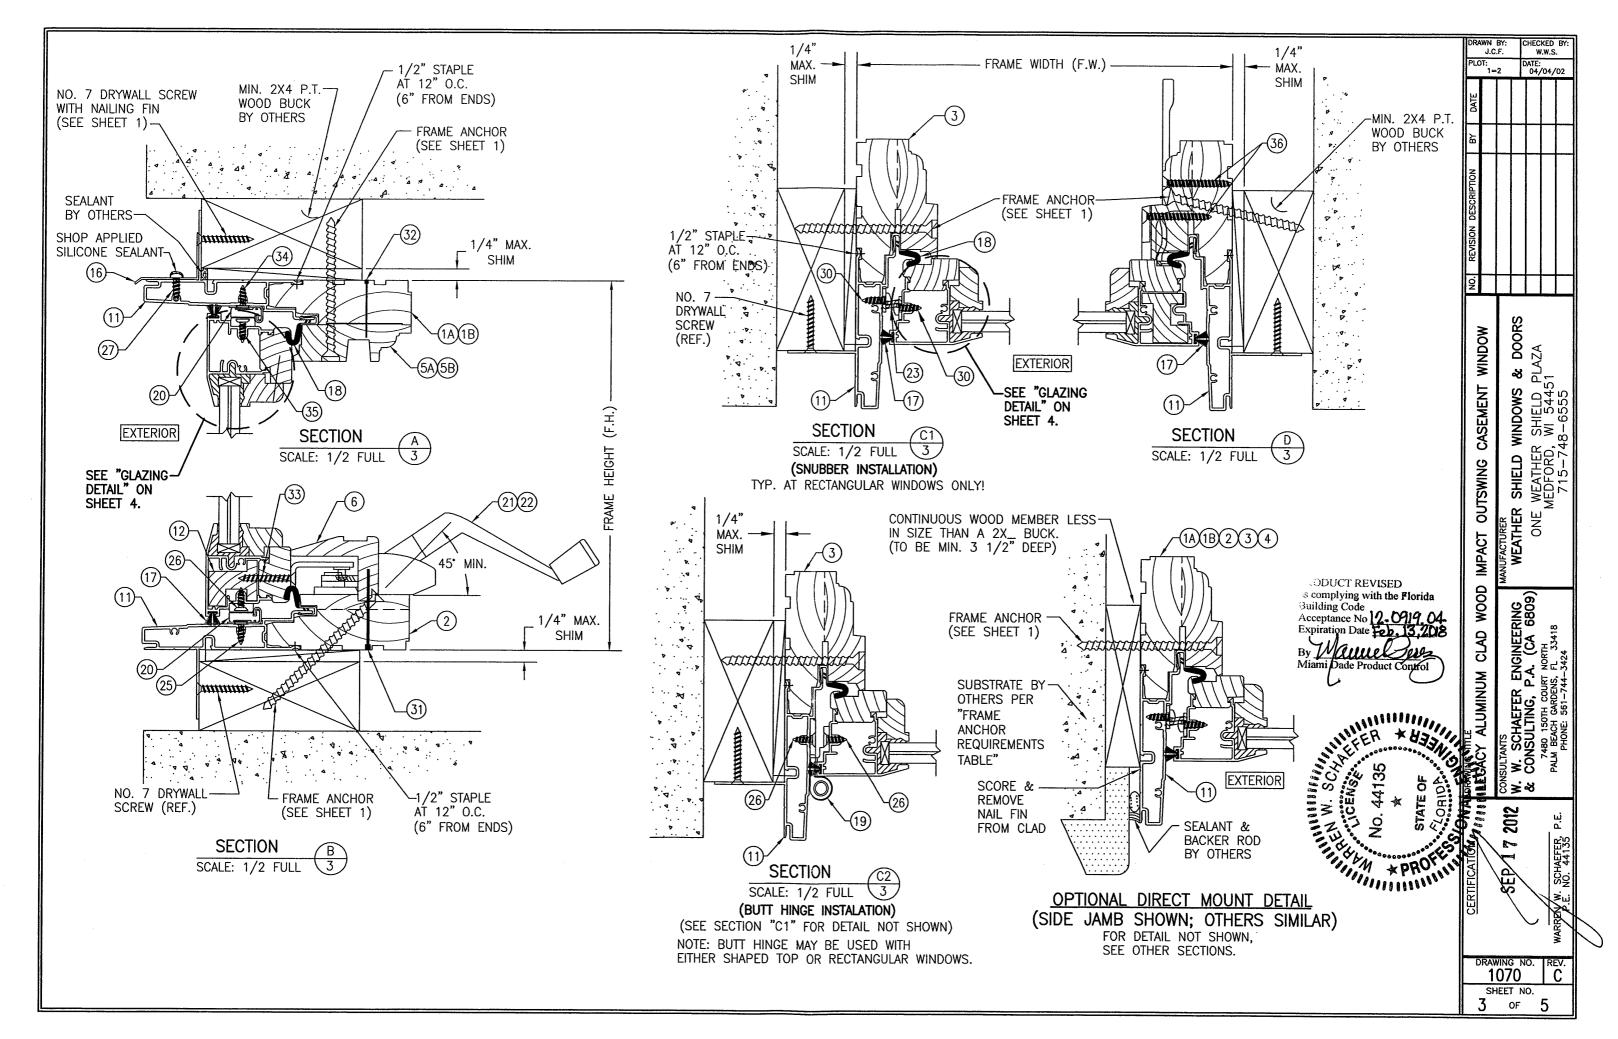

# GLAZING DETAIL

OPTION 1) 3/8" CARDINAL SEASTORM TYPE "B" LAMINATED GLASS (5/32" AN/0.045 PVB/0.007 PET/0.045 PVB/5/32" AN) OPTIONAL INNER LAYER MAY BE 0.075 PVB/0.007 PET/0.015 PVB.

OPTION 2) 7/16" SOLUTIA SAFLEX LAMINATED GLASS (3/16" H.S./0.09 SOLUTIA SAFLEX/ 3/16" H.S.) OPTION 3) 7/16" SOLUTIA SAFLEX LAMINATED GLASS (3/16" AN./0.09 SOLUTIA SAFLEX/ 3/16" AN.)

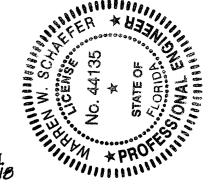

PRODUCT REVISED as complying with the Florida Expiration Date Feb

1070 SHEET NO. **4** of

CHECKED BY DATE: 04/04/02

DOORS

WINDOWS &

UFACTURER WEATHER SHIELD

ALUMINUM

SHIELD PLAZA WI 54451 8-6555

